




CONSTRUCTION KEYNOTES:

- ① MATCH INTO EXIST. SEE DETAIL 4 ON SHEET T-1.
- ② REMOVE EXIST AC AND RESTORE WITH AGGREGATE BASE, 4" THK, 127 SY.
- ③ PLACE ROCK SHOULDER TRANSITION. SEE DETAIL 3 ON SHEET T-1.
- ④ TAPER NEW AC TO MATCH EXIST PVMT. SEE DETAIL 5 ON SHEET T-1.
- ⑤ PROTECT EXISTING FRENCH DRAIN FROM BORGES STA 110+40 LEFT TO SE 242ND STA 21+50 LEFT.
- ⑥ MINOR ADJUST MANHOLE TO GRADE, METHOD C. SEE ODOT STD. DWG. RD360.
- ⑦ ADJUST BOX.
- ⑧ PROTECT EXIST FENCE.
- ⑨ PROTECT EXIST WALL.
- ⑩ PROTECT EXIST MANHOLE.
- ⑪ PROTECT EXIST GAS STAND PIPE.
- ⑫ PROTECT EXIST UTILITY POLE.
- ⑬ PROTECT EXIST GUY WIRE.
- ⑭ PROTECT EXIST TREE, TYP.
- ⑮ PROTECT EXIST FIBER OPTIC STAND PIPE.

EROSION CONTROL KEYNOTES

- ① INSTALL TYPE 3 INLET PROTECTION. SEE ODOT STD. DWG. RD1010.
- ② INSTALL SEDIMENT FENCE. SEE ODOT STD. DWG. RD1040.
- ③ INSTALL TYPE 6 COMPOST FILTER SOCK CHECK DAM. SEE ODOT STD. DWG. RD1006.

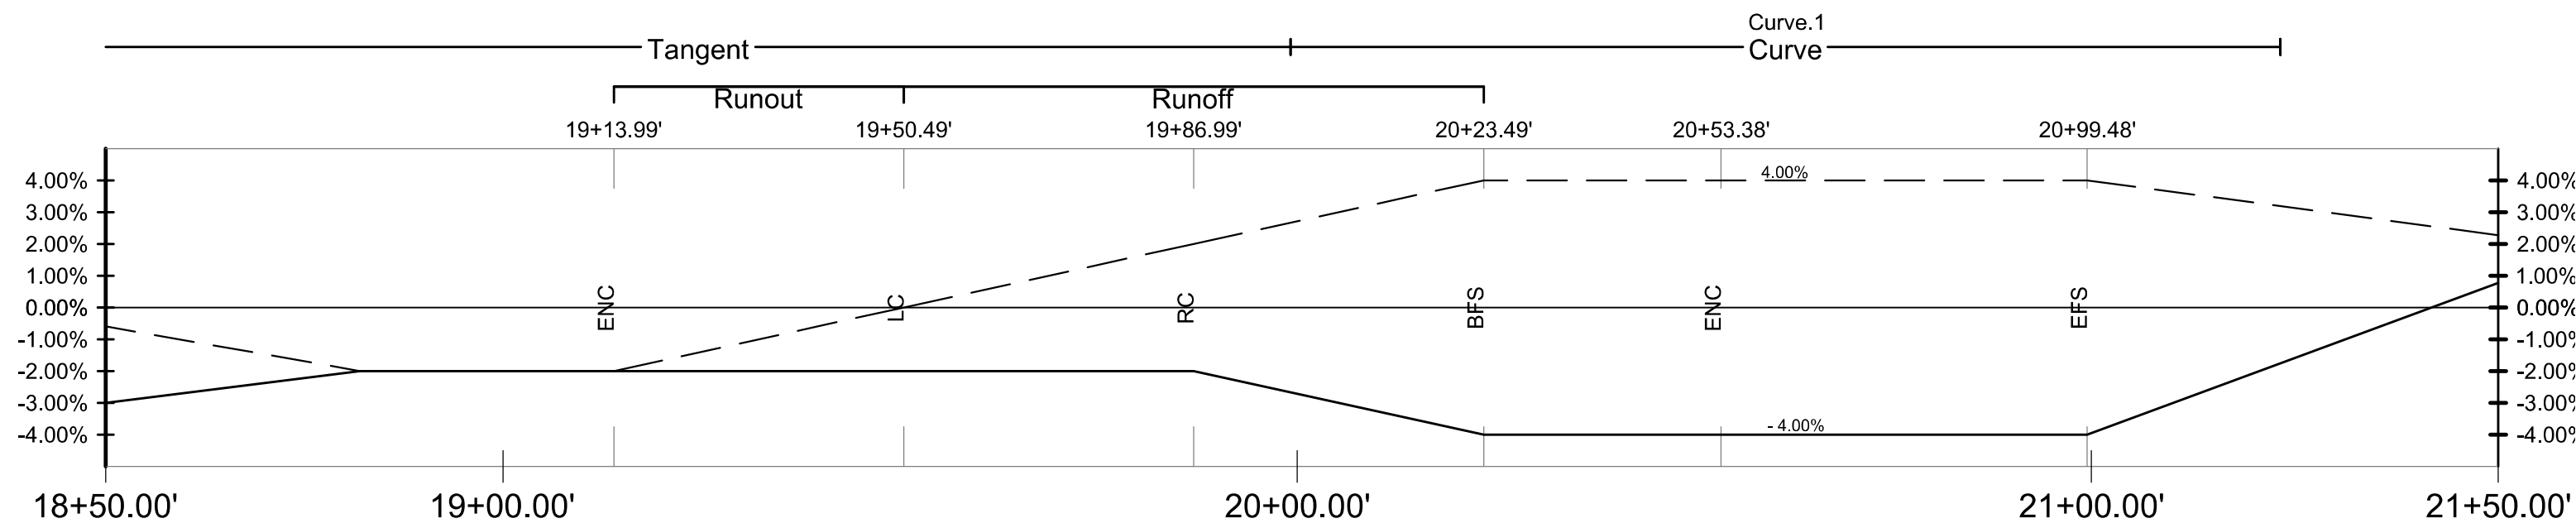

SE 242ND AVENUE SUPERELEVATION
SCALE: 1"=20' HORIZ

LEGEND

- LEFT EOP ————
- RIGHT EOP ————
- EXIST. ROADWAY CENTERLINE ————

NO.	DATE	REVISION

DESIGNED: RPW
DRAWN: WIE
CHECKED: WFA
APPROVED: NJM



SCALE	VERT: AS SHOWN	HORIZ: AS SHOWN

NOTICE
IF THIS BAR DOES NOT MEASURE 1" THEN DRAWING IS NOT TO SCALE

SE 242ND AVENUE AND SE BORGES ROAD REALIGNMENT PROJECT NO. 22279

ROADWAY PLAN STA 18+50 TO STA 21+50

PROJECT: 19-2714 DATE: FEBRUARY 2021

BY: _____

SHEET **C-1** OF 10